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The Contractor is to check and verify all building and site dimensions, levels and sewer invert levels at connection points before work starts. The Contractor is to comply in all respects with current Building Legislation, British Standard Specifications, Building Regulations, Construction (Design & Management) Regulations, Party Wall Act, etc. whether or not specifically stated on this drawing. This drawing must be read with and checked against any structural, geotechnical or other specialist documentation provided.

This drawing is not intended to show details of foundations, ground conditions or ground contaminants. Each area of ground relied upon to support any structure depicted (including drainage) must be investigated by the Contractor. A suitable method of foundation should be provided allowing for existing ground conditions. Any suspect or fluid ground, contaminates on or within the ground, should be further investigated by a suitable expert. Any earthwork constructions shown indicate typical slopes for guidance only & should be further investigated by a suitable expert.

Where existing trees are to be retained they should be subject to a full Arboricultural inspection for safety. All trees are to be planted so as to ensure they are a minimum of 5 metres from buildings and 3 metres from drainage and services. A suitable method of foundation is to be provided to accommodate the

Sketch proposals are for illustrative purposes only & as such are subject to detailed site investigation including ground conditions/contaminants, drainage, design & planning/density negotiations. Sketch proposals may be based upon enlargements of OS sheets & visual estimations of existing site features, accuracy will therefore need to be verified by survey. Sketch proposals have not been considered in respect of CDM Regulations.

Rev

Date

23/09/21 Updated to suit LPA comments

PLANNING

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CONEYGRE

REDEVELOPMENTS LTD


PROJECT: LAND OFF


CONEYGRE ROAD


TIPTON


UNIT 3 & 4 ELEVATIONS & SECTION - AS PROPOSED

Scale: 1:200 @ A1	Date : AUG 2021
Design : -	Draft : SL
Drg No : 19-103-PA-08	Revision: A

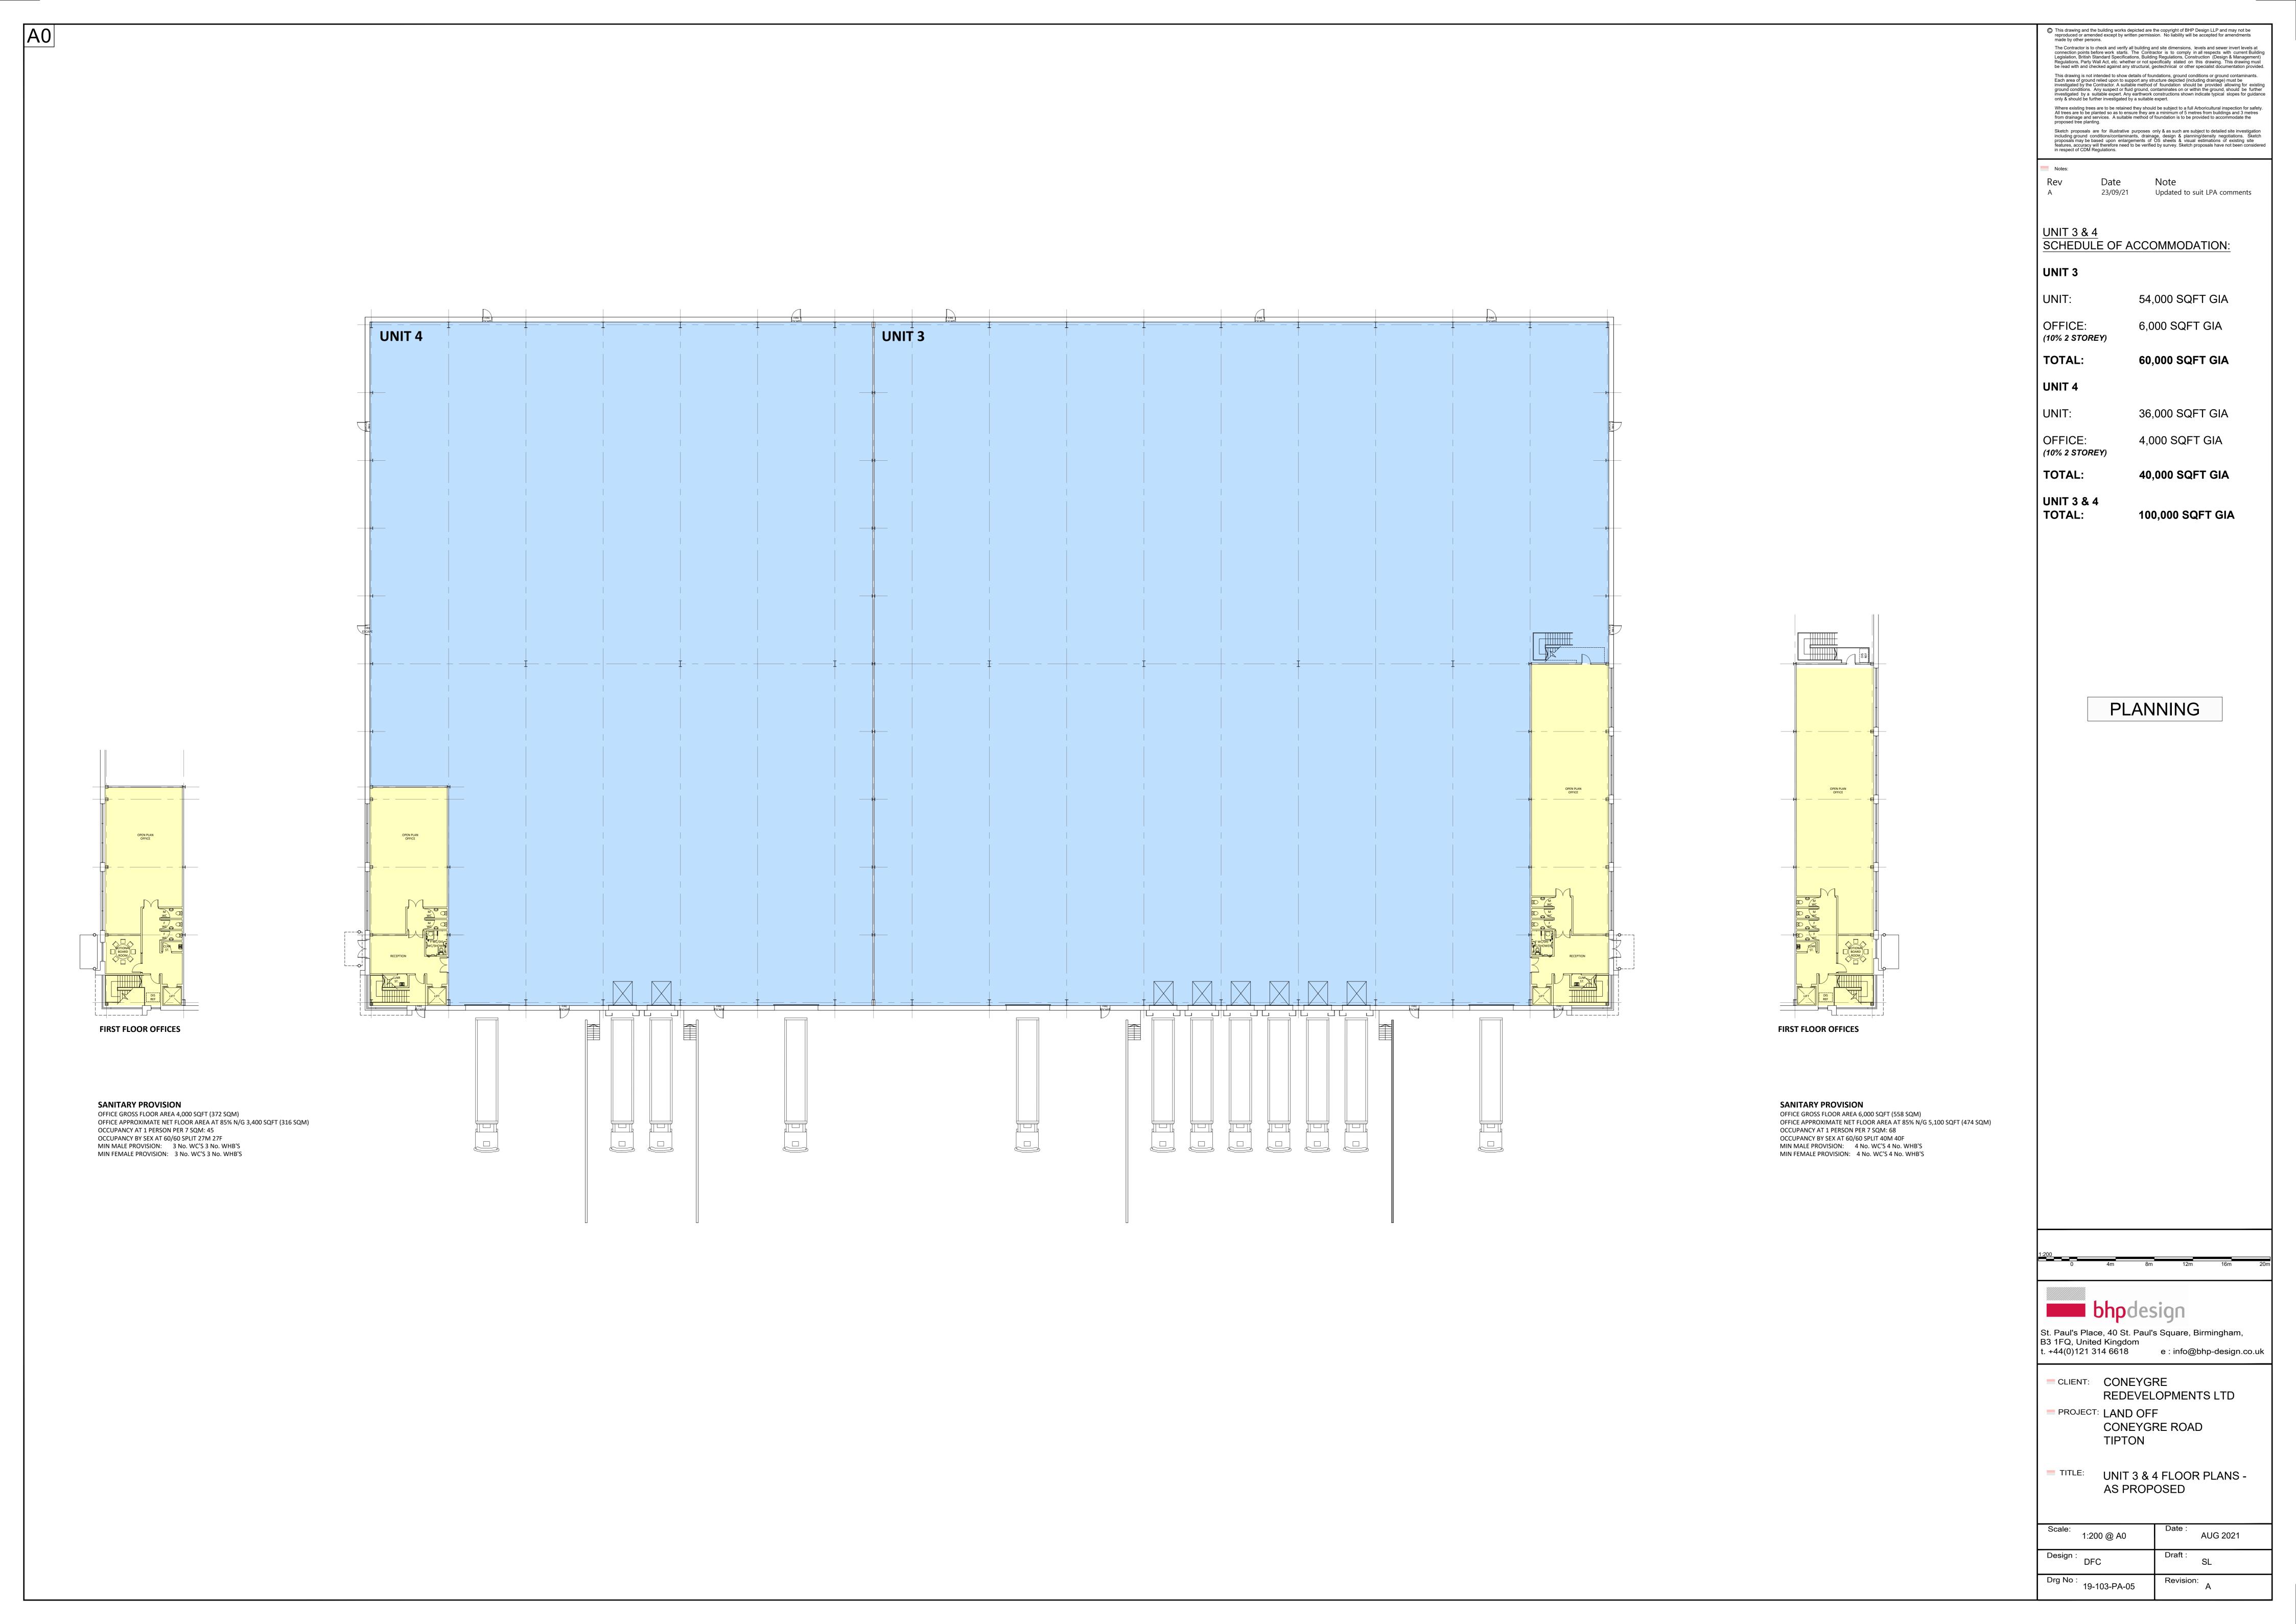


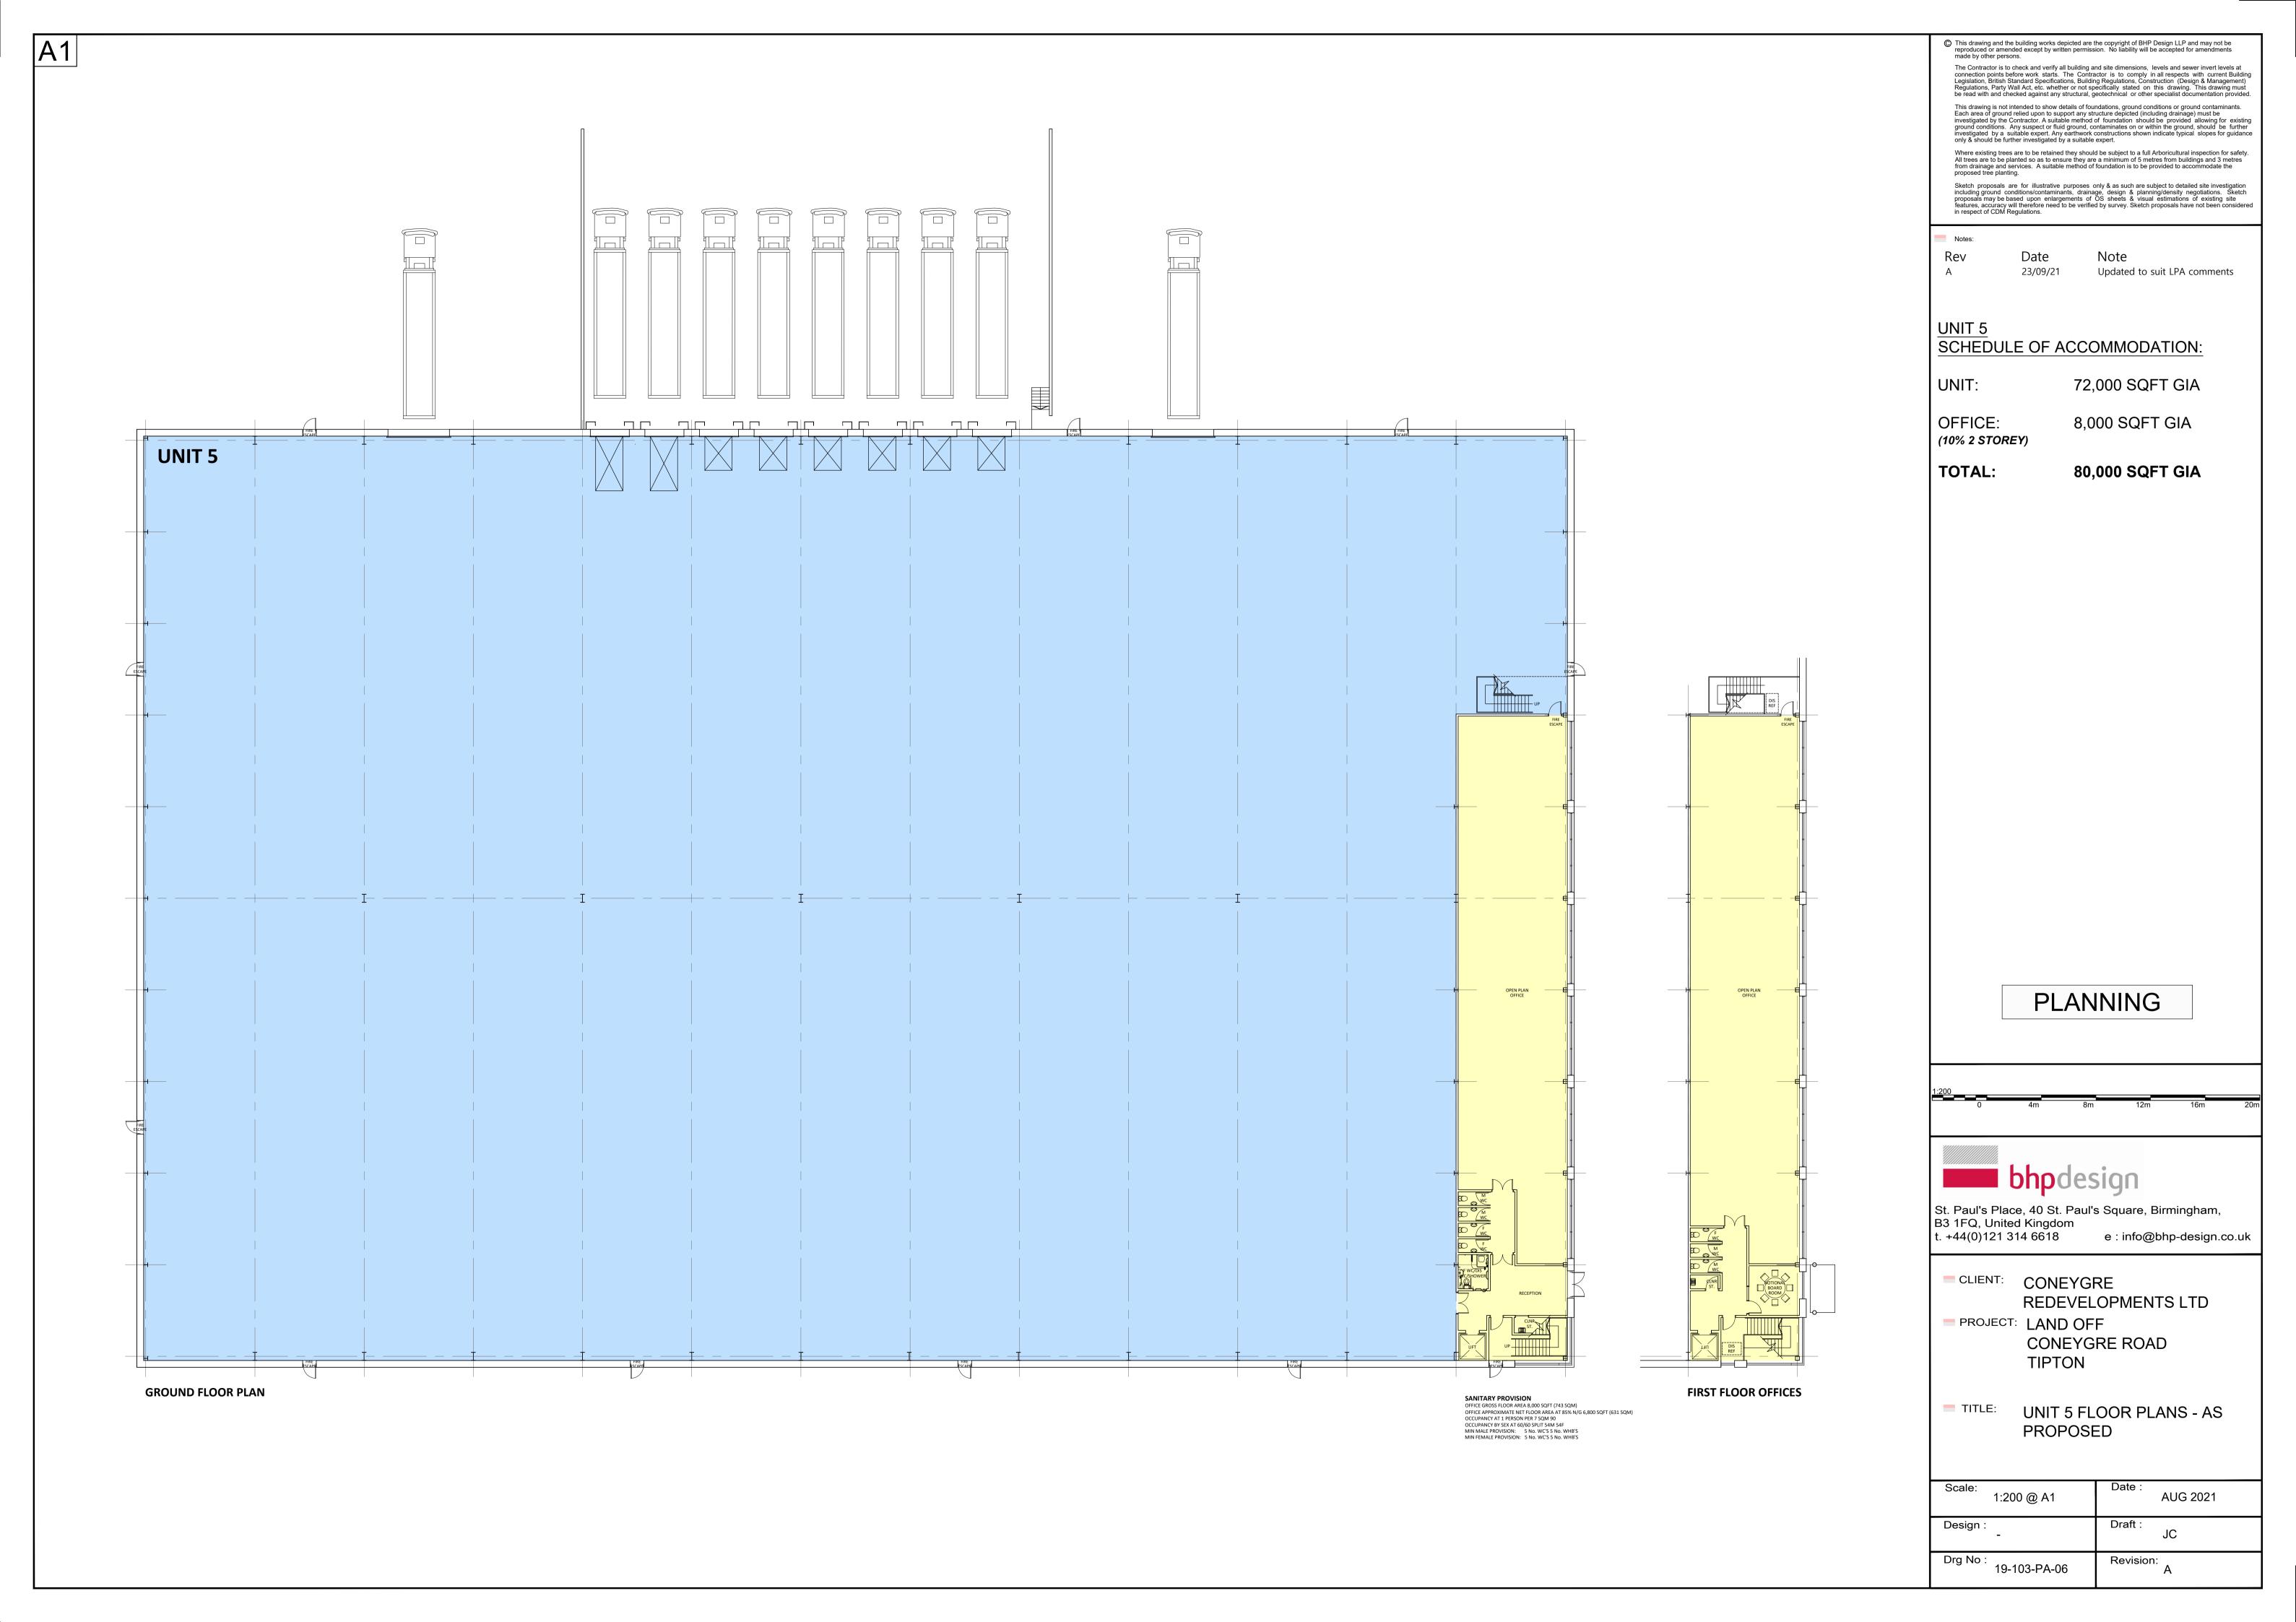

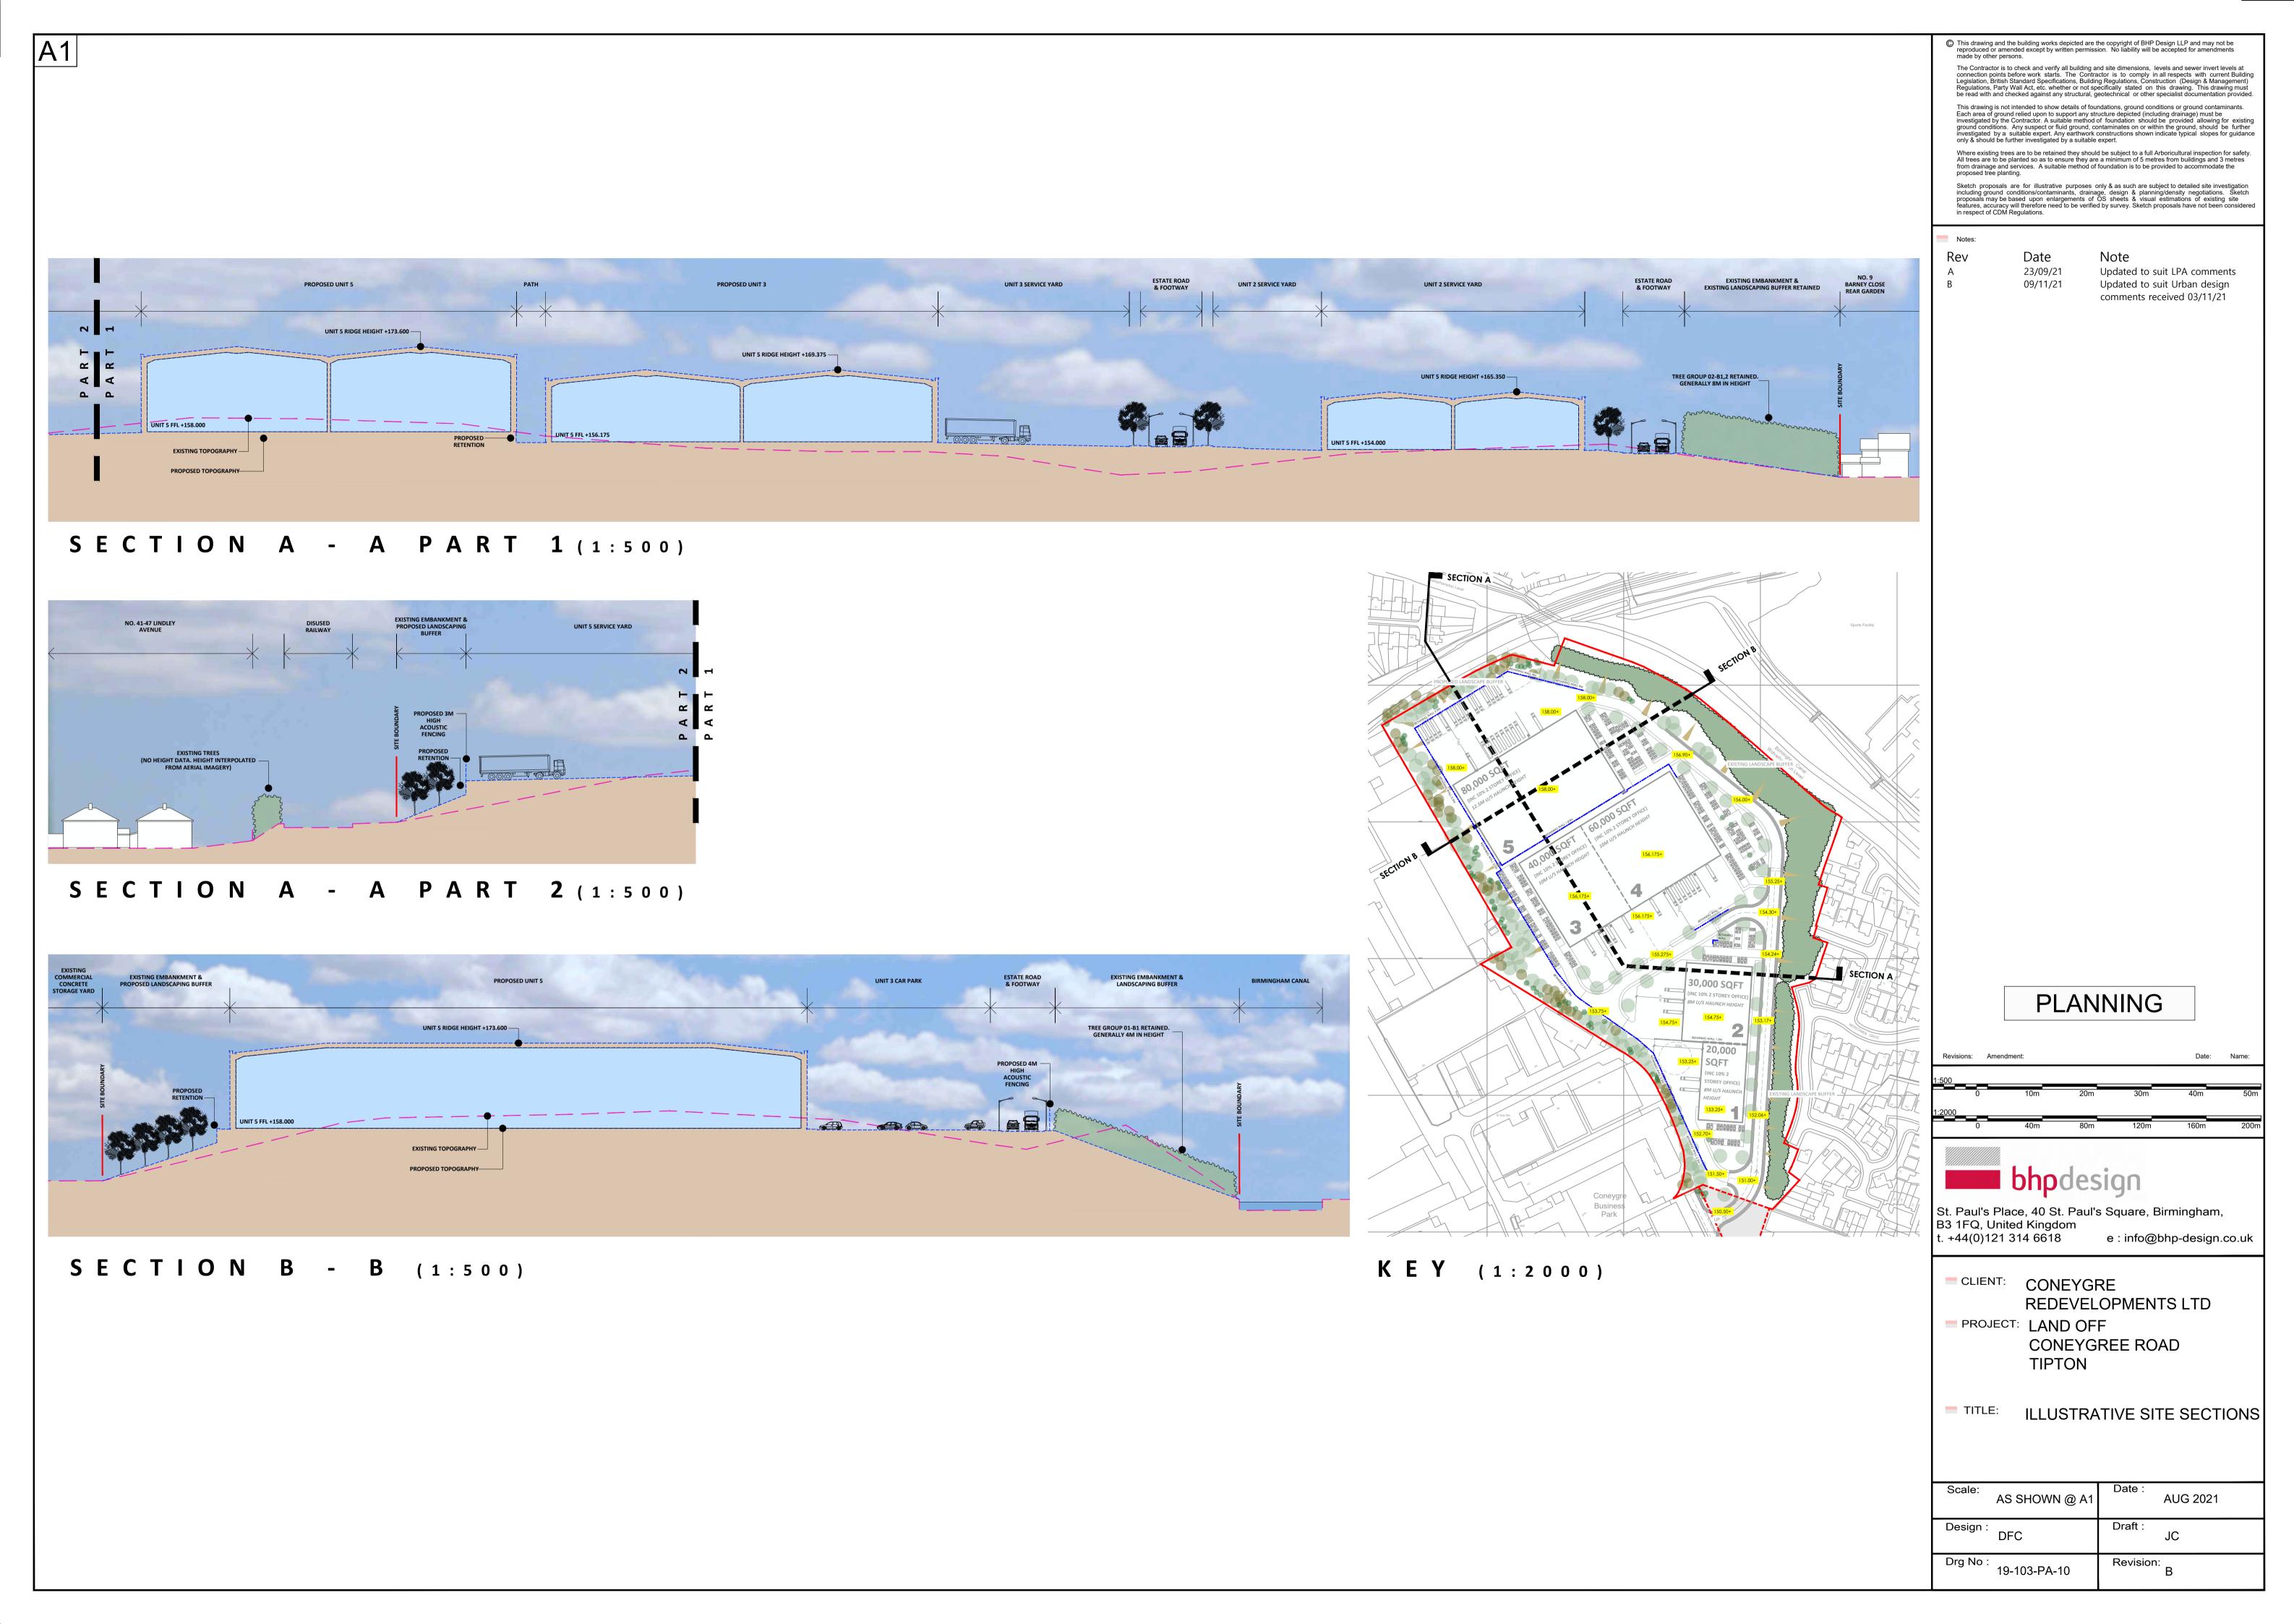


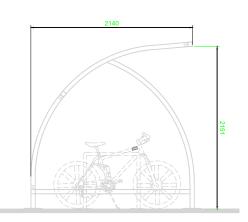

SIDE ELEVATION

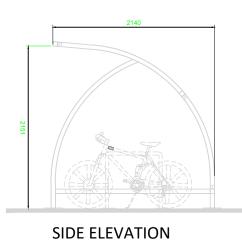

FRONT ELEVATION

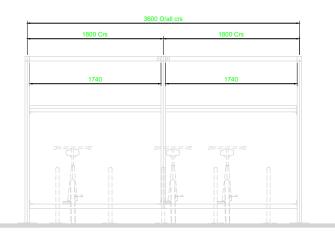

REAR ELEVATION

CYCLE SHELTER SPECIFICATION.


50X50 SHS FRAME WITH 50X50 SHS PURLINS & TRIMMERS. WELDED END FRAMES AND PURLIN SECTION MADE FROM HEAVY-DUTY BOX SECTION ASSEMBLED WITH ANTI-TAMPER HIGH STRENGTH BOLTS.

ALL COMPONENTS TO BE GALVANISED WITH POLYESTER POWDER COAT FINISH

COLOUR BLACK WITH STANDARD CLEAR P.E.T SHEET ROOF PANELS.

CYCLE SHELTER TO BE BROXAP BXMW/SEF/36

EACH SHELTER TO ACCOMMODATE 8 No. CYCLES.

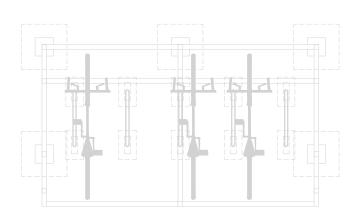

PLAN

PROPOSED CYCLE SHELTER DETAILS







ILLUSTRATIVE PERSPECTIVES

23/09/21

PLANNING

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CONEYGRE REDEVELOPMENTS LTD

PROJECT: LAND OFF
CONEYGREE ROAD **TIPTON**

TYPICAL CYCLE SHELTER DETAILS

Scale: 1:50 @ A3	Date : AUG 2021
Design: DFC	Drawn: JC
Drw No : 19-103-PA-12	Revision: A

